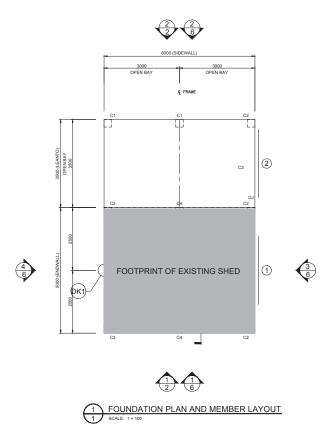
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NORTHERN CONSULTING

Civil & Structural Engineers 50 Punari Street

Currajong, Qld 4812 Fax: 07 4725 5850 design@nceng.com.au ABN 341 008 173 56


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Regn. No. 2558980 Regn. No. 9985 Regn. No. 116373ES Regn. No. EC36692 Regn. No. CC5648M

Mr Timothy Roy Messer BE MIEAust RPEQ

Signature

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(CONTACT) CLARENCE VALLEY SHEDS

02 6643 2742

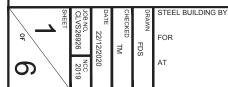TRISH BURGESS 173 ALICE STREET GRAFTON




DO NOT SCALE THIS DRAWING. USE FIGURED DIMENSIONS ONLY. ALL DIMENSIONS TO BE VERIFIED ON SITE


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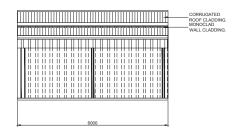
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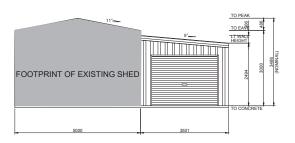






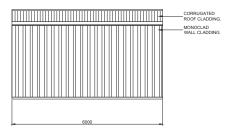



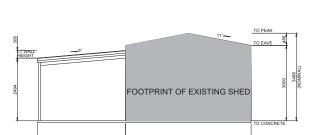



WALL	PAPERBARK	
ROOF	PALE EUCALYPT	
ROLLER DOOR	PAPERBARK	
DOWNPIPE	PAPERBARK	
GUTTER	PALE EUCALYPT	
CORNER FLASHING	PAPERBARK	
BARGE FLASHING	PALE EUCALYPT	
OPENING FLASHING	PAPERBARK	

		DATE	CHEC	DRAWN	STEEL BUILDING BY
ျှီလ	S26926	22/12	KED TW	ž E	FOR
6	NCC 201	2020	2	S	AT

(CONTACT) CLARENCE VALLEY SHEDS

02 6643 2742

TRISH BURGESS 173 ALICE STREET GRAFTON





Email: design@nceng.com.au

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Civil & Structural Engineers 50 Punari Street Currajong, Qld 4812 Fax: 07 4725 5850 ABN 341 008 173 56 Date Regn. No. 2558980 Regn. No. 9985 Regn. No. 116373ES Regn. No. EC36692 Regn. No. CC5648M

Signature


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Mr Timothy Roy Messer BE MIEAust RPEQ

SITE PLAN: TRISH BURGESS
173 ALICE STREET
GRAFTON 2460

LOT 1 / DP 784287

SCALE 1:100

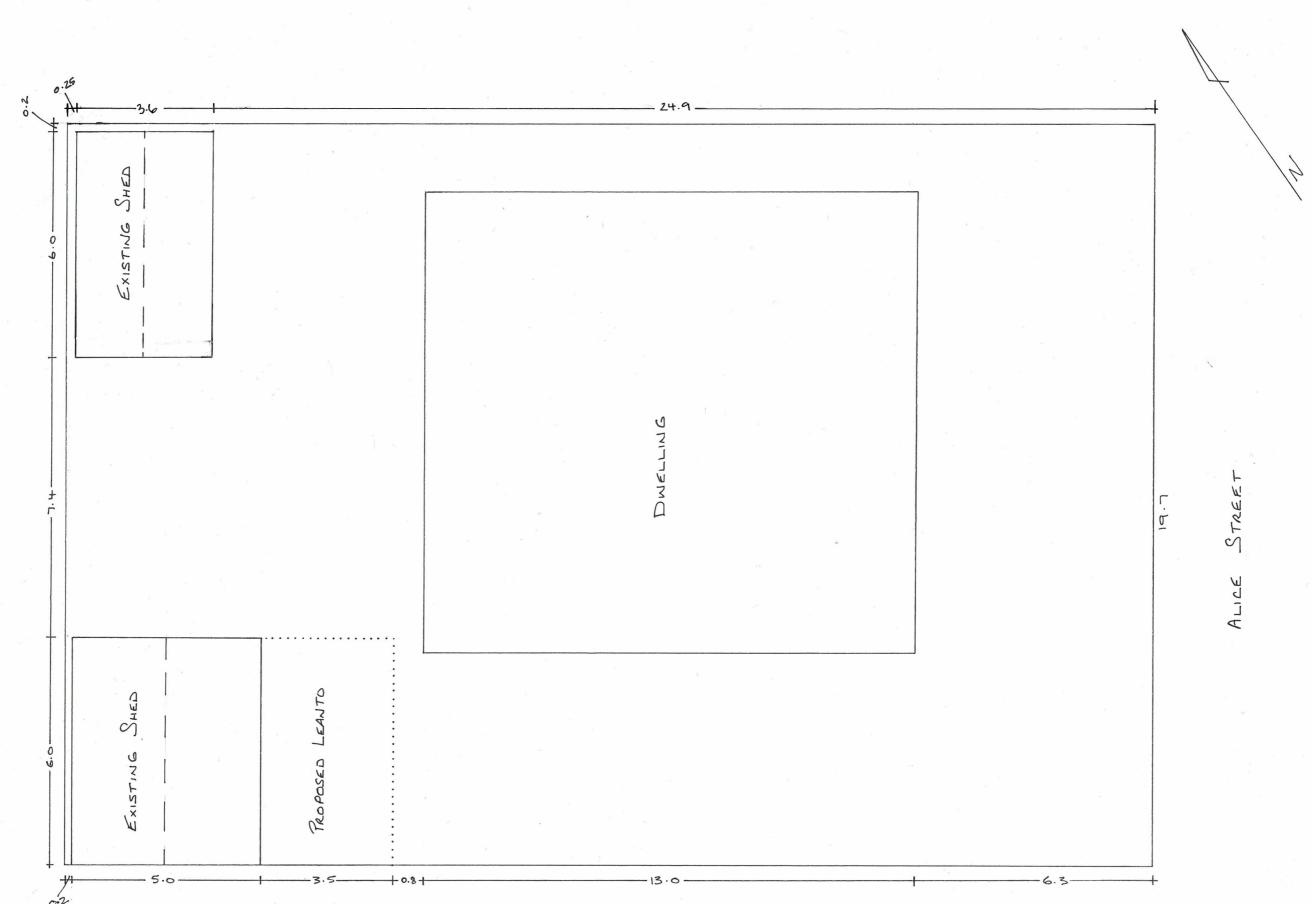

22/12/2020

Schedule 1 Draft Advices and Conditions of Consent for DA2021/0060 173 Alice Street Grafton

Advices

No construction is to commence until a Construction Certificate has been issued.

Conditions

1. The development being completed in conformity with the Environmental Planning & Assessment Act, 1979, the Regulations thereunder, the Building Code of Australia (BCA) and being generally in accordance with the following plan(s) as amended in red, or where modified by any conditions of this consent.

P	Plan No	Drawn by	Plan Date	Sheet No	Revision
C	CLVS	Clarence Valley	22/12/2020	1, 6 and site plan	-
2	26926	Sheds		(3 sheets)	

- 2. No portion of the carport is to be further enclosed without prior written approval being obtained from Council.
- 3. All building work shall be constructed wholly within the boundaries of the property. The location of the boundary shall be verified by a registered surveyors report prior to construction commencing.
- 4. Roof water, including overflow from a tank, is to be connected to the existing stormwater disposal system.
- 5. **Working/Construction Hours** Working hours on construction or demolition shall be limited to the following:

7.00 am to 6.00 pm Monday to Friday 8.00 am to 1.00 pm Saturdays No work permitted on Sundays and public holidays

The builder is responsible to instruct and control sub contractors regarding the hours of work and the requirements of the Protection of the Environment Operations Act 1997 and Regulations.

6. **Site Safety Management** Building equipment and/or materials shall be contained wholly within the site and shall not be stored or operated on the footpath or roadway, unless specific written approval has been obtained from Council beforehand.

All excavations and back filling associated with the erection and demolition of a building must be executed safely and in accordance with appropriate professional standards and must be properly guarded and protected to prevent them from being dangerous to life or property.

- 7. Any extension to the vehicular crossing to provide access to the allotment is to be constructed in accordance with the requirements of Council's Operations Section. An application for driveway access crossing is to be submitted and approved by Council prior to any work commencing.
- 8. External colours shall match the existing structure.
- 9. The carport and slab shall be located at least 200mm from the sewer boundary shaft and the slab shall be piered to below the zone of influence of the boundary shaft with a minimum 200mm diametre mass concrete pier.
- 10. The development is not to be occupied or used until such time as an Occupation Certificate has been issued.